

Meridian Water Project: External Visual



Project Summary: With the main aim of this proposal being to bridge the gap between 2 communities, this courtyard was created along with the roof top terrace to create a safe space for residents to hangout, collaborate with each other and forge new connections. The Drawing: This visual was made using Autodesk Revit to highlight the atmosphere of the courtyard at 5pm in the evening and how the different materials and surfaces interact. The large floor to ceiling glazed curtain wall was implemented to invite the public into the community centre.

Drawing: Sheet Size: A3 Scale: N/A Page: 2

Visual



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Meridian Water Project: Internal Visual



Project Summary: With the main aim of this proposal being to bridge the gap between 2 communities, this Atrium breakout space was created for residents to hangout, collaborate with each other and forge new connections. The Drawing: This visual was made using Autodesk Revit to highlight how the atrium breakout space looks at night. Meeting rooms on the first floor are exposed, promoting a productive environment and was designed to be a step in the right direction to boosting the economy.

Drawing: Sheet Size: A3 Scale: N/A Page:

Visual


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Meridian Water Project: Massing Development + Final Site Plan




Lines from surrounding building edges informing the massing of this proposal

Creating an enclosed courtyard for collaboration between Upper Edmonton and Meridian Water

The process of reducing the massing area whilst adding various height levels to the massing

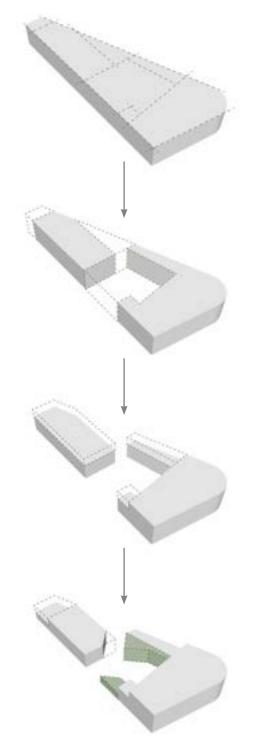Amending the massing to improve the practicality and layout of functions and to invite the public into the site

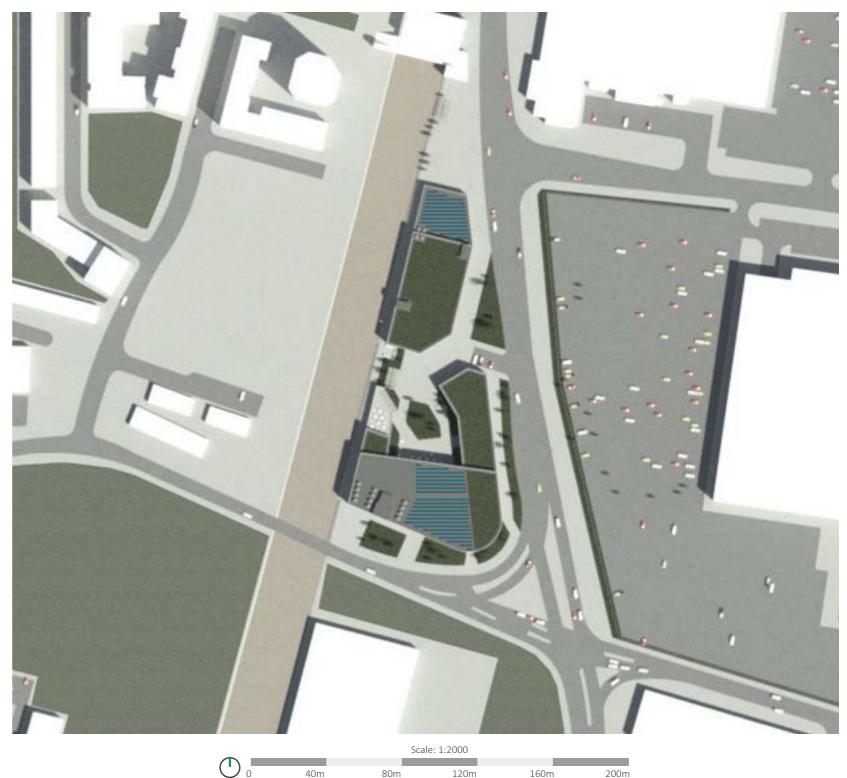

Project Summary: With the main aim of this proposal being to bridge the gap between 2 communities, the project's massing connects with its surrounding area due to its volume and site-build ratio whilst also funnelling the public into the courtyard to promote further connection. Massing Diagram: This diagram was made using Sketchup and illustrator to highlight where the massing shape came from and its development. Site Plan: This drawing was made using Autodesk Revit and Photoshop to showcase how the proposal sits within it surrounding site

Drawing: Sheet Size: A3 Scale: Page: 4

80m

40m

160m

200m

Site Plan 1:2000

120m



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Meridian Water Project: East Elevation (Angel Edmonton Road)



Project Summary: With the main aim of this proposal being to bridge the gap between 2 communities, the project's external cladding connects with the surrounding area's typology (Industrial warehouses) with corrugated metal sheet panels. Elevation: This drawing was made using Autodesk Revit and Photoshop to highlight the buildings cladding, size and height in relation to its surrounding area. Additionally, how users would interact with the proposal internally and externally.

Drawing: Sheet Size: Α3 Scale: 1:200 5 Page:

Elevation



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Meridian Water Project: Cross Section Through the Sports Builling




Project Summary: With the main aim of this proposal being to bridge the gap between 2 communities, the sports building is part of phase 3 of the proposal which aims to further promote connections between both neighbourhoods, through sport and recreation. Elevation: This drawing was made using Illustrator and Photoshop, and highlights how the building interacts with its immediate surrounding are whilst tackling with certain environmental issues such as the impact loads from fast trains passing with a shear wall and plant room buffer to minimize noise.

Drawing:SecSheet Size:A3Scale:1:2Page:6




Meridian Water Project: Green Roof Detail + Wall/Column Component Detail

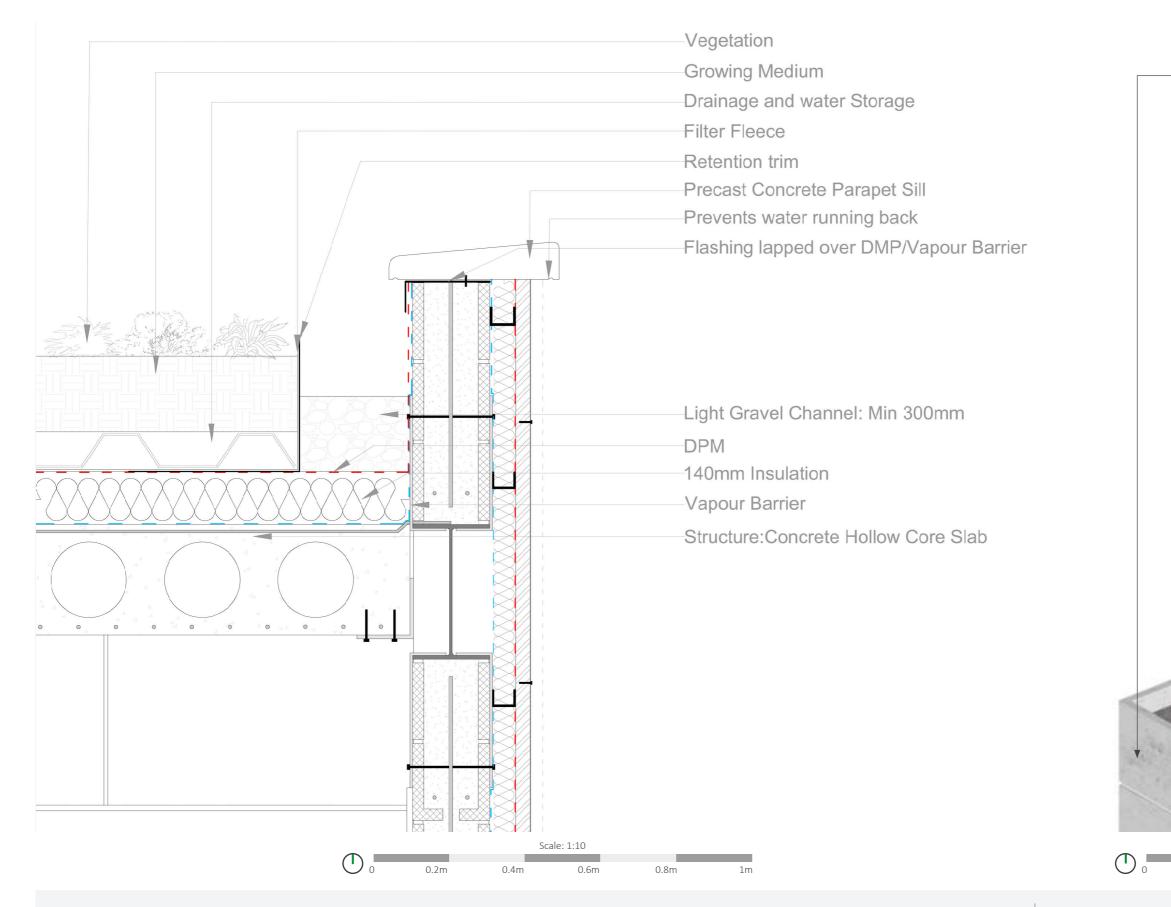

Detail (Left): This Green roof - external wall detail was made using AutoCAD, and highlights how the assembly of the extensive green roof is supported by the hollow core concrete floor slab that is attached to the steel I beam on the external cladding wall Axonometric Detail (Right): This component detail was made using Illustrator and Sketchup, and highlights the intricate detail of how the CMU block is attached to the steel column through the wire anchor holding the reinforced steel bar that is submerged in the concrete mix in the CMU block.

Drawing:DetailSheet Size:A3Scale:1:10Page:7


0.2m

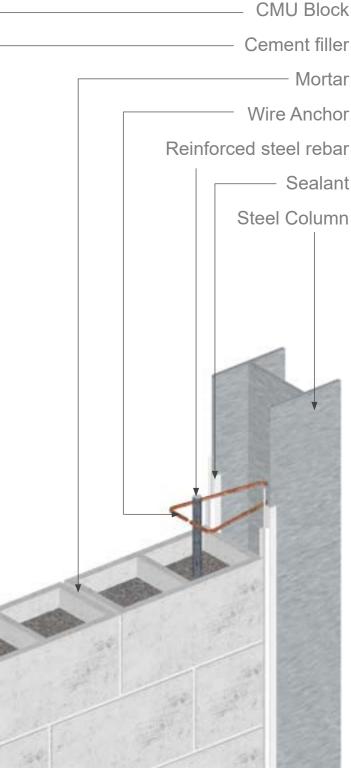



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Jewellery Quarter Project: Double Skin Facade

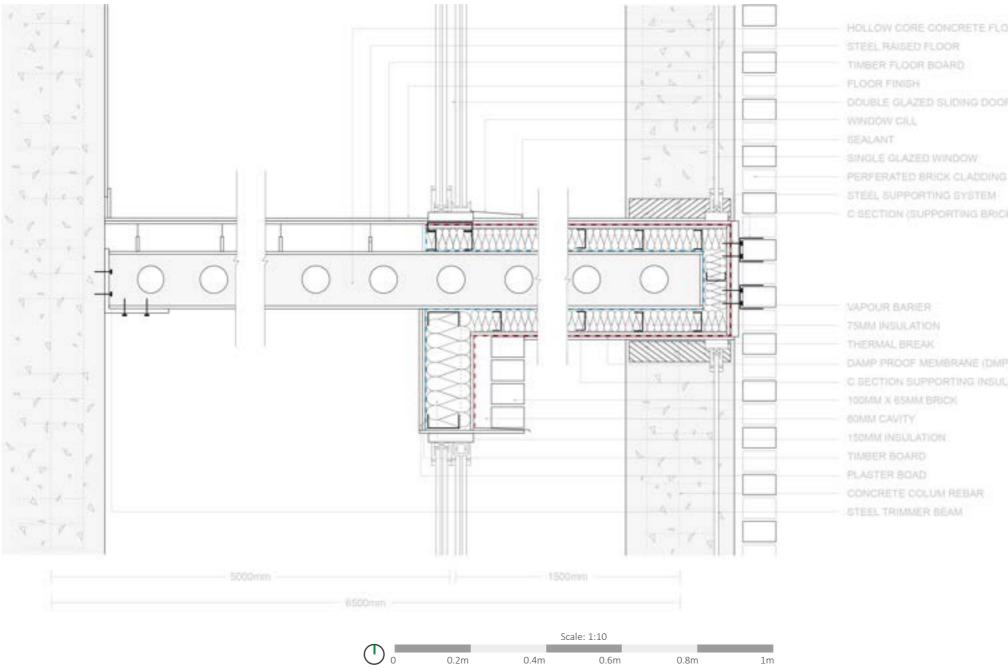

Project Statement: A jewellery making community centre where the public can learn about the history of the area and learn a new skill. The project was inspired by the area, hence, connects with its urban context, connections within the facade materials and promoting user connection and collaboration Detail: The Double Skin Facade Detail was drawn using illustrator and designed as part of the south east facade for environmental, acoustic and aesthetic reasons with a perforated brick cladding design.


Drawing: Detail Sheet Size: A3 1:10 Scale: 8 Page:



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Residential Single Story Rear Extension: Ground Floor Floorplan



Project Statement: The client was looking to extend the existing conservatory (dashed orange line) to create a large living dining and kitchen space to accommodate 20-30 guests on the weekends without compromising on the view into the garden from the study.

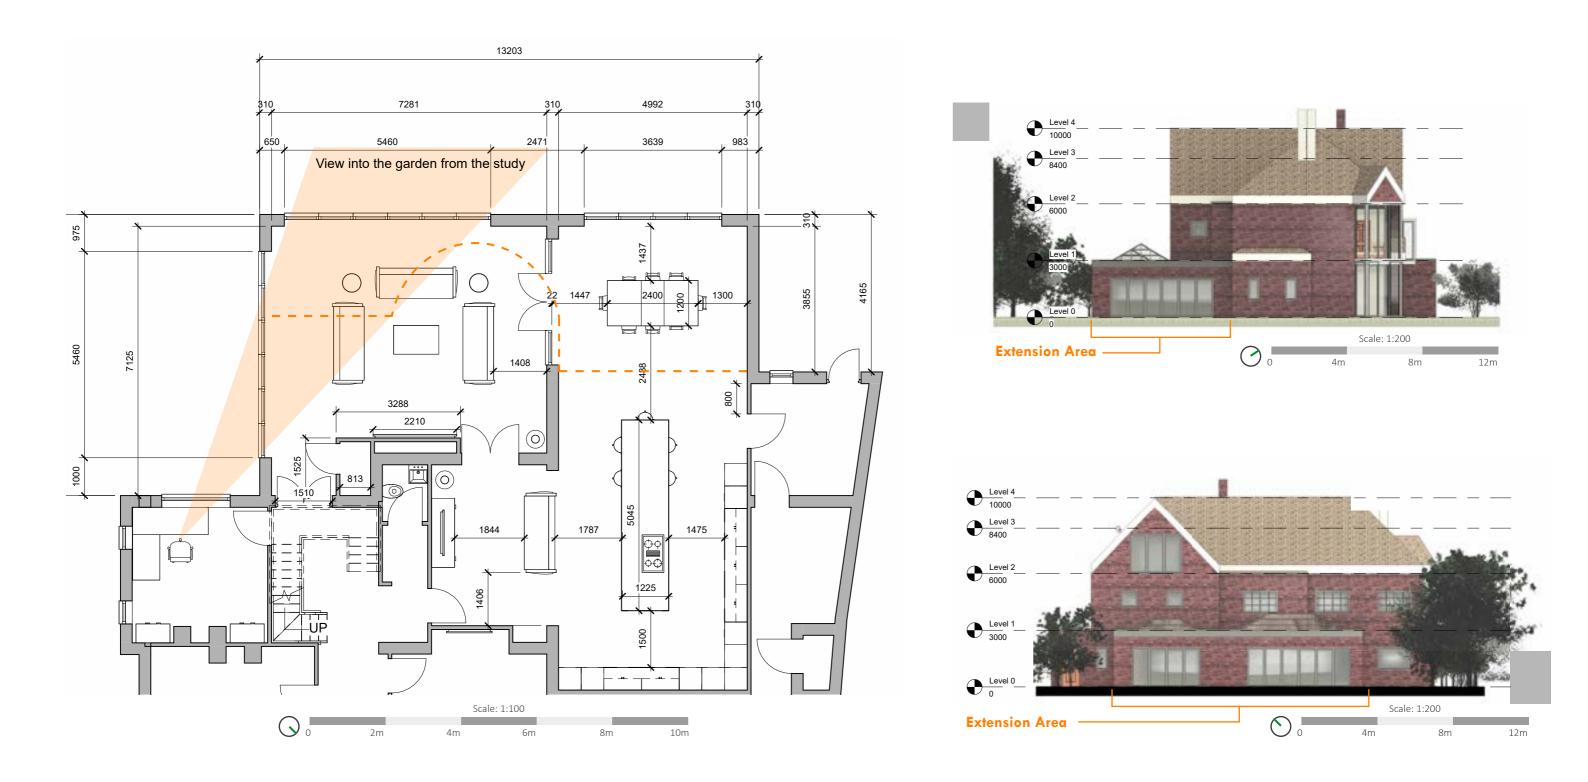The Drawings: The floor plan and elevations were drawn using AutoDesk Revit and annotated using Illustrator to highlight the proposal in comparison to the existing building with relevant dimensions for the client to understand the size of the space and furniture drawn.

Drawing: Sheet Size: Scale: Page:

Floorplan 1:100/200

A3


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Interior Renovation for an SME Office Space





The Drawing: These visuals were made using Sketchup and Photoshop and were used to showcase to the client the proposed office space at different sections of the floorplan.

Drawing: Visuals Sheet Size: A3 Scale: N/A 10 Page:

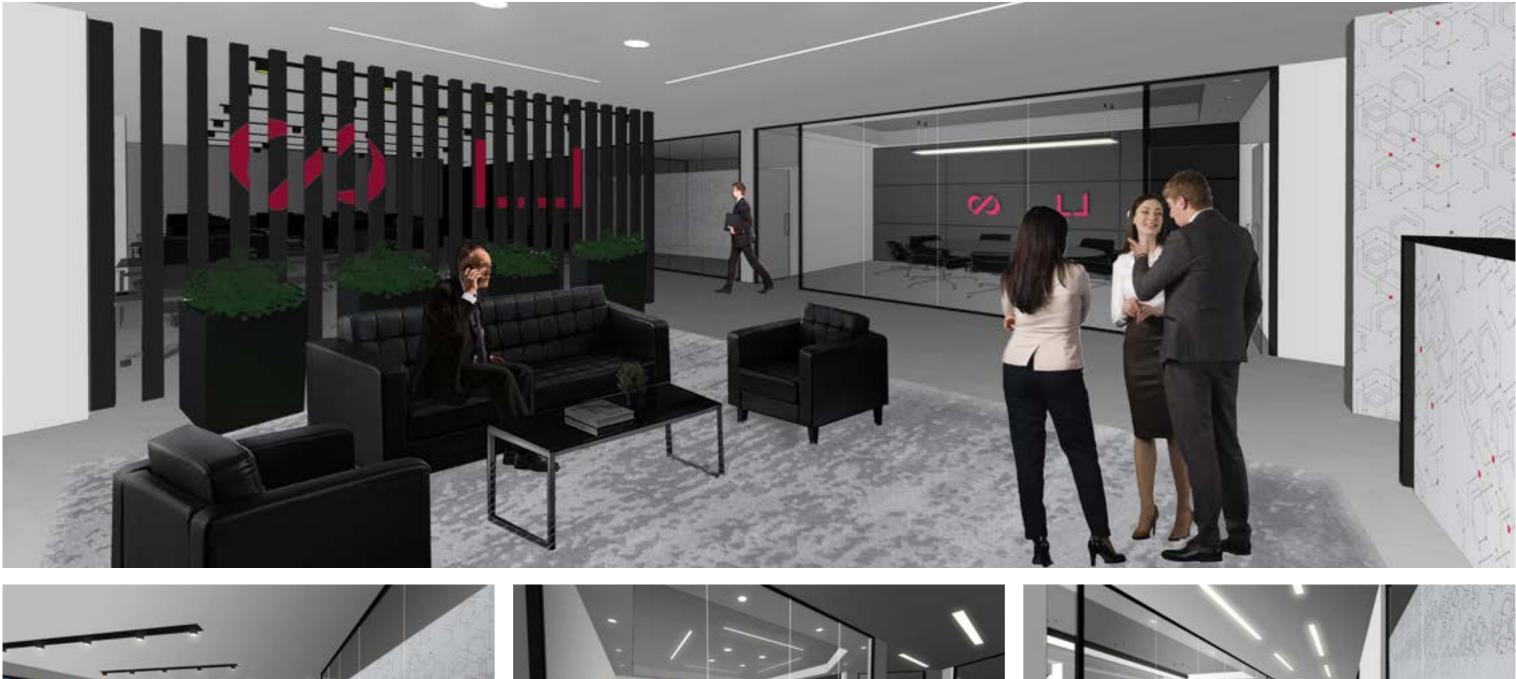



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Architecture Display Model



Project Statement: The client was looking to showcase their newly acquired property to the community to help in fundraising the project, with an architectural model to be placed at the entrance of their current centre.

The Drawing: This physical handmade model was intentionally created without external walls to the building as requested by the client to showcase the scale or the property and potential for interior renovation. The only aspects that were sourced included cars, trees, lights, bikes, benches and people.

Drawing: Model Sheet Size: A3 Scale: 1:100 Page: 11



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